



BEAUFORT BULKHEAD & BOARDWALK REPAIR BEAUFORT CARTERET COUNTY NORTH CAROLINA

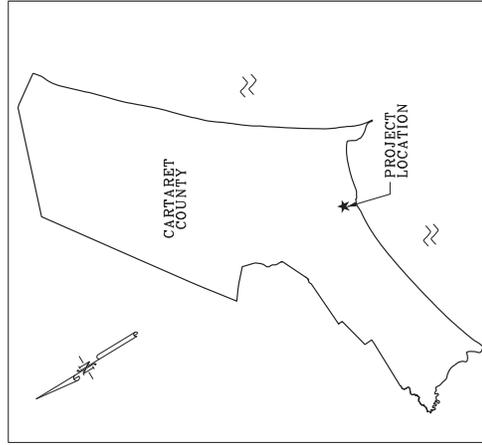

VICINITY MAP

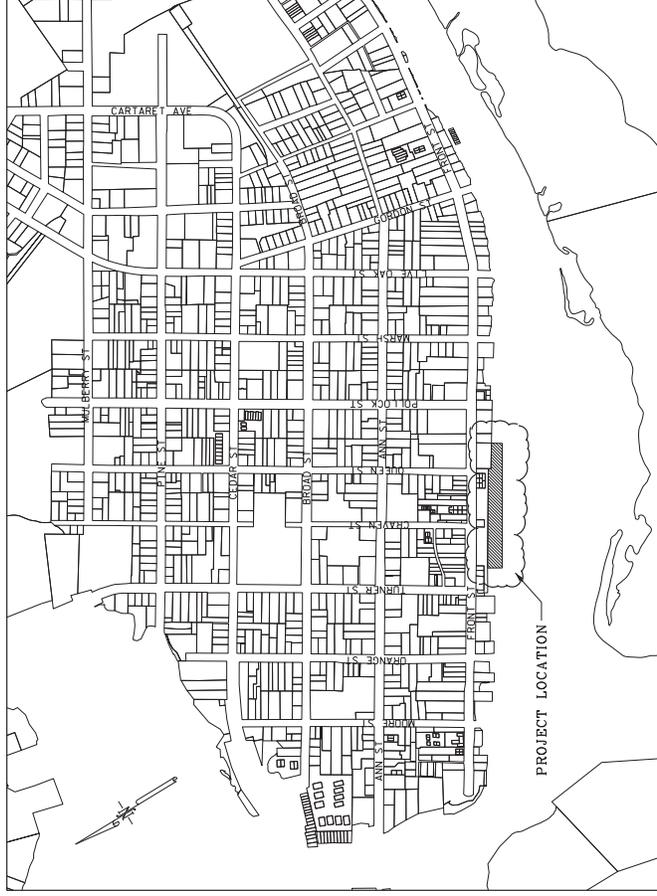


PROJECT LOCATION MAP

SCALE: 1"=400'

SHEET INDEX

SHEET 1	COVERSHEET
SHEET 2	EXISTING CONDITIONS & DEMOLITION PLAN
SHEET 3	PROPOSED CONDITIONS PLAN
SHEET 4	EXISTING CONDITIONS & DEMOLITION PLAN
	PROPOSED CONDITIONS PLAN

PRELIMINARY DRAWING
DO NOT USE FOR
CONSTRUCTION

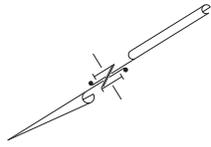

- LEGEND
- LIGHTING
 - △ WATERMETER
 - TELEPHONE PEDESTAL
 - ELECTRIC PANELS
 - ⊙ SANITARY PUMP STATION
 - ⊙ TELECOMMUNICATIONS
 - ⊙ ELECTRIC SUPPLY
 - ⊙ FUEL HOODUP
 - ⊙ LIGHT EXTINGUISHER
 - ⊙ LIGHT
 - ⊙ WATER BIB

REVISIONS

NO.	DATE	DESCRIPTION

EXISTING CONDITIONS & DEMOLITION PLAN

BEAUFORT BULKHEAD & BOARDWALK REPAIR

BEAUFORT, CURRUMET COUNTY, NORTH CAROLINA

OWNER:
ADDRESS:
PHONE:

DESIGNED: LES DATE: 2/9/18
DRAWN: LSK SCALE: 1"=10'
APPROVED: LES SHEET 4 OF 9


STROUD ENGINEERING, P.A.
1001 W. STATE ST. SUITE 5
LITTLE ROCK, AR 72114

PRELIMINARY DRAWING
DO NOT USE FOR
CONSTRUCTION



A
4

EXISTING CONDITIONS & DEMOLITION PLAN
SCALE: 1"=10'

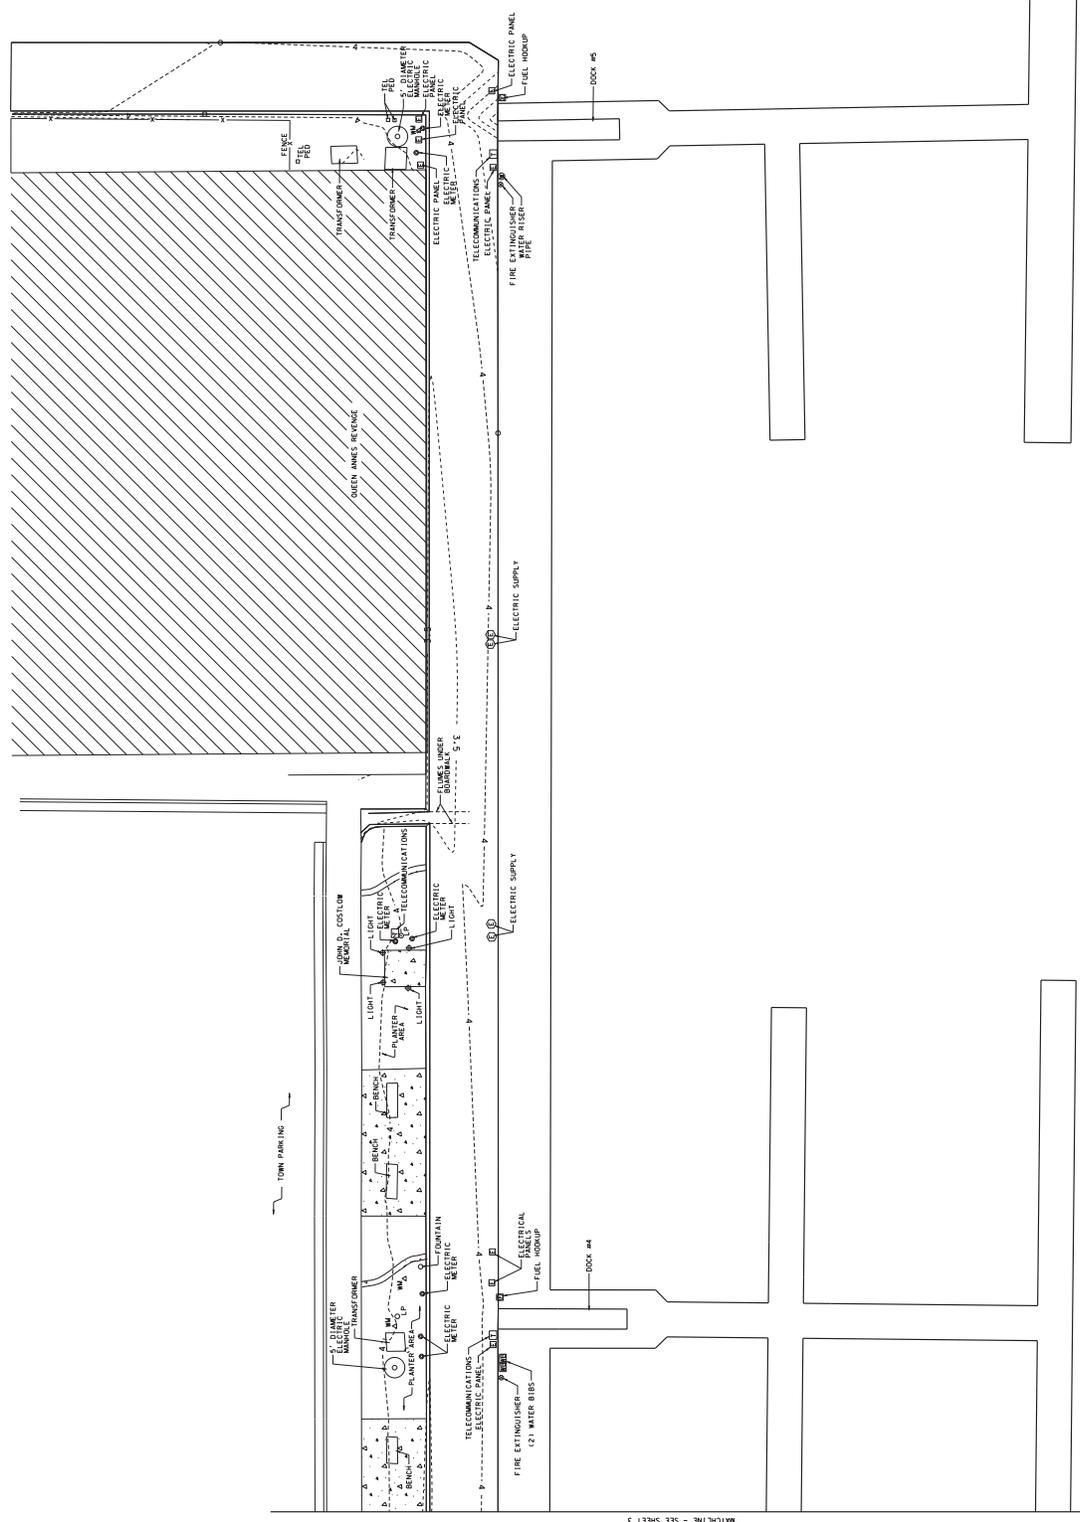

MATCH LINE - SEE SHEET 3

PROJECT NO.: 201803-3500
DRAWING NO.:



PROGRESS PRINT
 2/2/2018
 NOT FOR CONSTRUCTION

REVISIONS	
#	DATE

DESIGNED: MEB
 DRAWN: WRB
 CHECKED:
 PROJECT:
 DATE: XX XXXXXXXX 2018

TOWN OF BEAUFORT
 BEAUFORT BULKHEAD AND
 BOARDWALK REPAIR
 BEAUFORT, NORTH CAROLINA 28516
 EXISTING TIE BAR AND SOIL ANCHOR PLAN

SD101

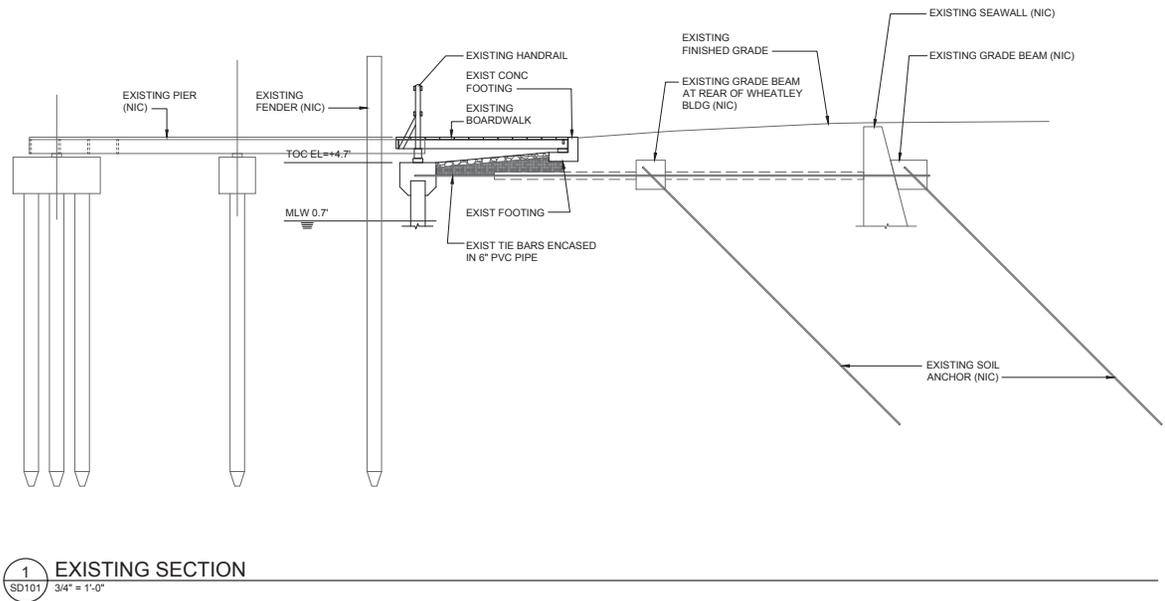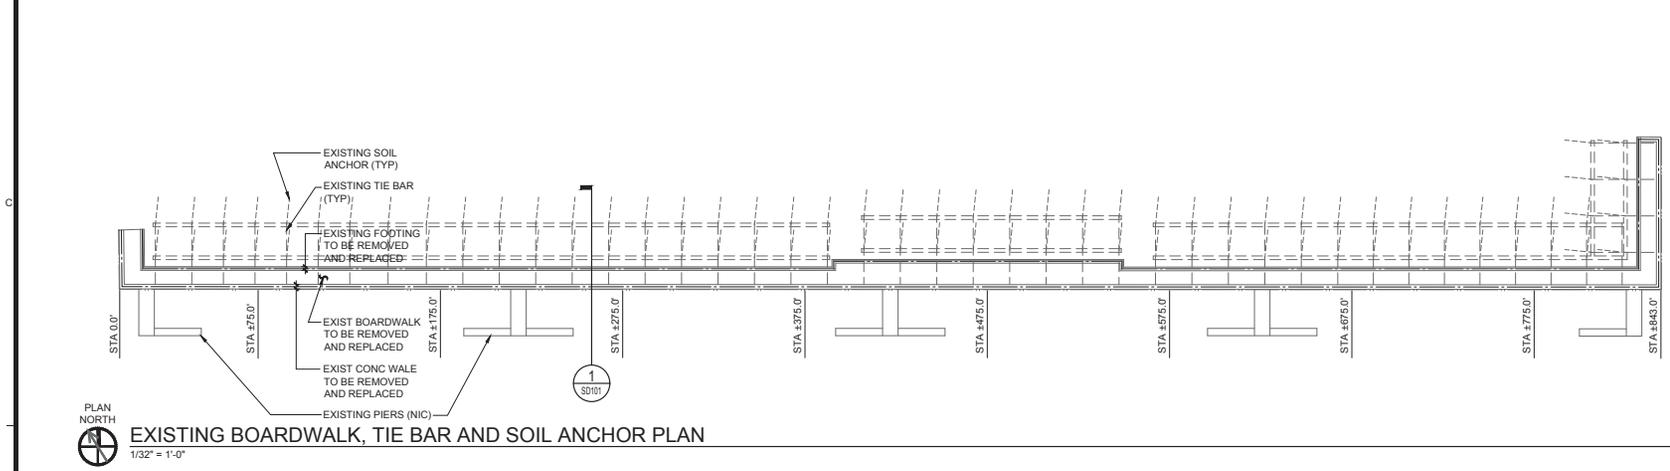


1
 SD101
 3/4" = 1'-0"


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REVISIONS	
#	DATE DESCRIPTION


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 DRAWN: WRB
 CHECKED:
 PROJECT:
 DATE: XX XXXXXXXX 2018

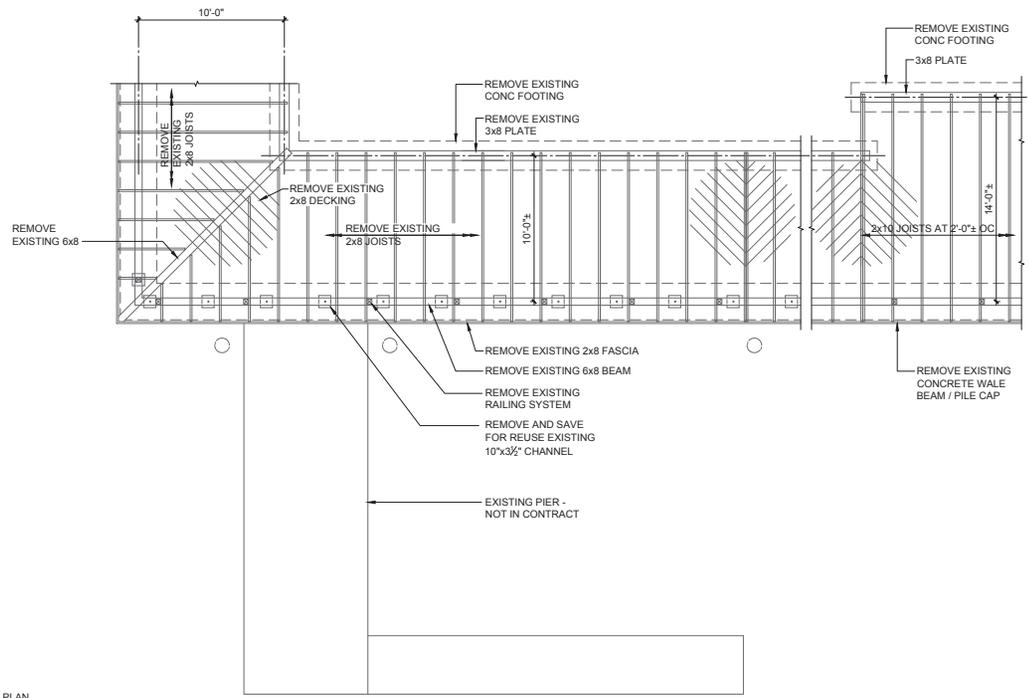


EXISTING BOARDWALK PLAN
 1/4" = 1'-0"

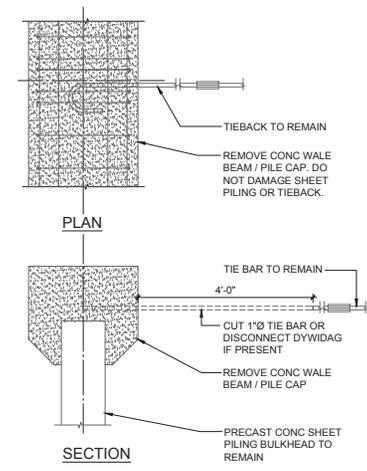


EXISTING WALE BEAM / PILE CAP
 1 1/2" = 1'-0"

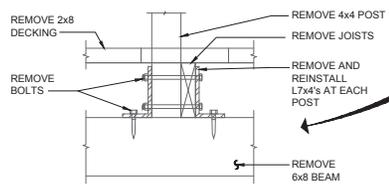

EXISTING POST CONNECTION
 1 1/2" = 1'-0"

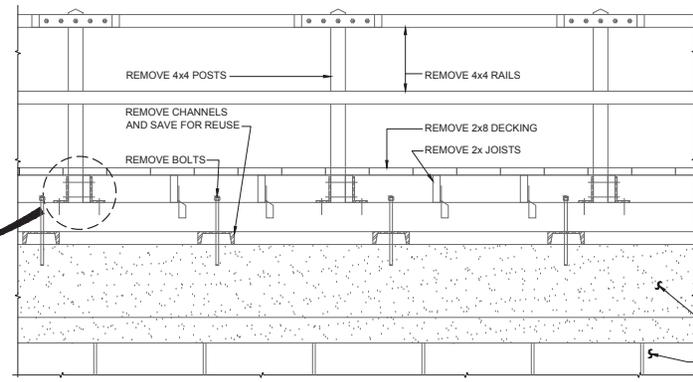

EXISTING BOARDWALK ELEVATION
 3/4" = 1'-0"




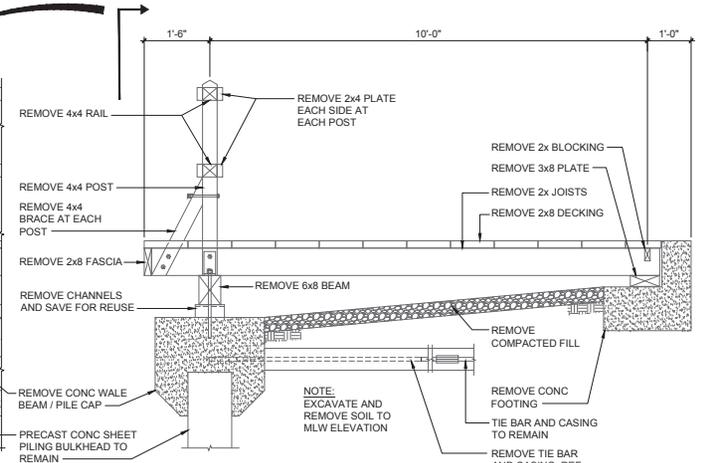


EXISTING BOARDWALK SECTION
 3/4" = 1'-0"

PROGRESS
 PRINT
 2/2/2018
 NOT FOR
 CONSTRUCTION

REVISIONS		
#	DATE	DESCRIPTION


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 DRAWN: WRB
 CHECKED:
 PROJECT:
 DATE: XX XXXXXXXX 2018

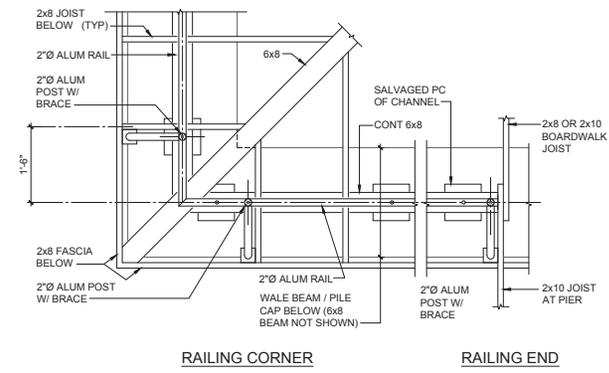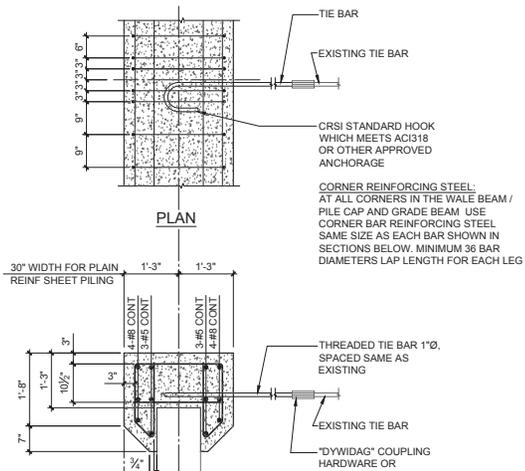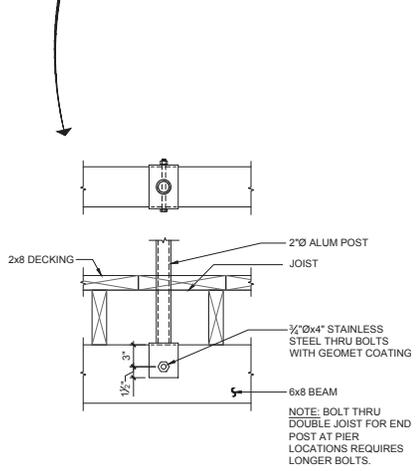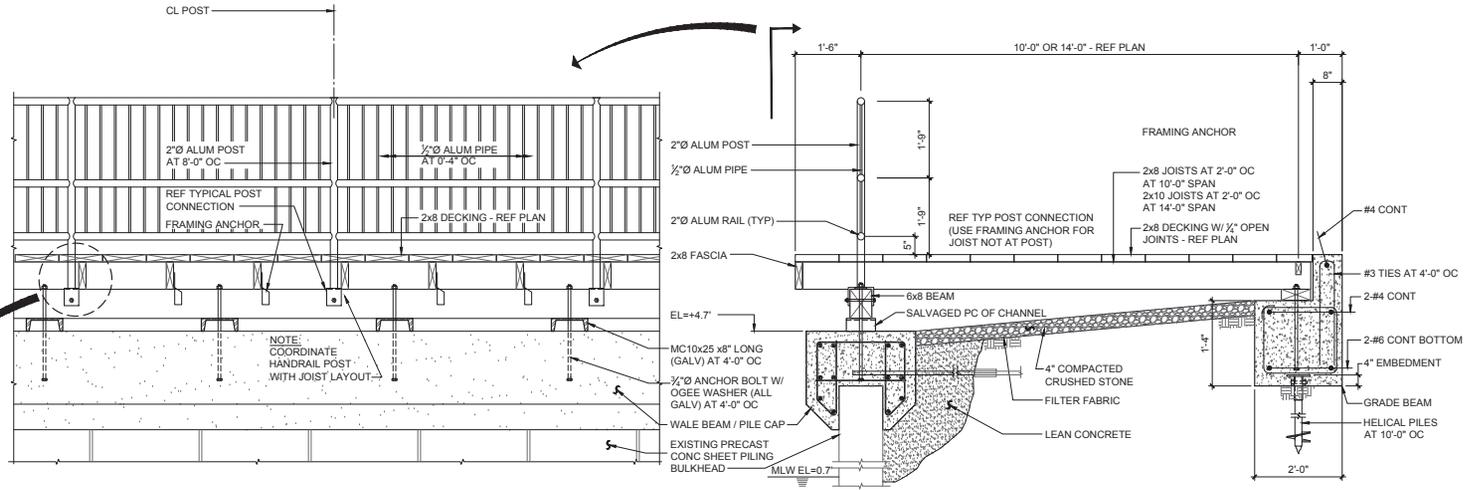

TOWN OF BEAUFORT
 BEAUFORT BULKHEAD AND
 BOARDWALK REPAIR
 BEAUFORT, NORTH CAROLINA 28516


SECTIONS

S301

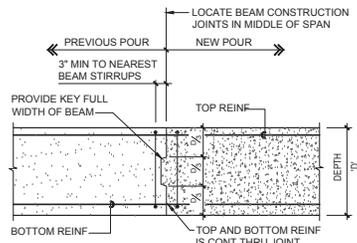

**TYPICAL GRADE BEAM
CONSTRUCTION JOINT DETAIL**

NTS

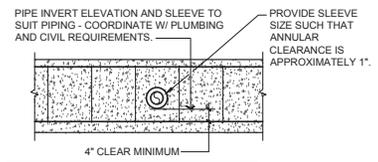

4" CLEAR MINIMUM

UNDER NO CIRCUMSTANCES SHALL ANY TOP OR BOTTOM REINFORCING OR STIRRUPS BE DISCONTINUED TO PLACE GRADE BEAM SLEEVES.

TYPICAL SLEEVED GRADE BEAM DETAIL



NTS

REVISIONS	
#	DESCRIPTION

DESIGNED: MEB
 DRAWN: WRB
 CHECKED:
 PROJECT:
 DATE: XX XXXXXXXX 2018

TOWN OF BEAUFORT
**BEAUFORT BULKHEAD AND
BOARDWALK REPAIR**
BEAUFORT, NORTH CAROLINA 28516
 TYPICAL DETAILS


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A
2

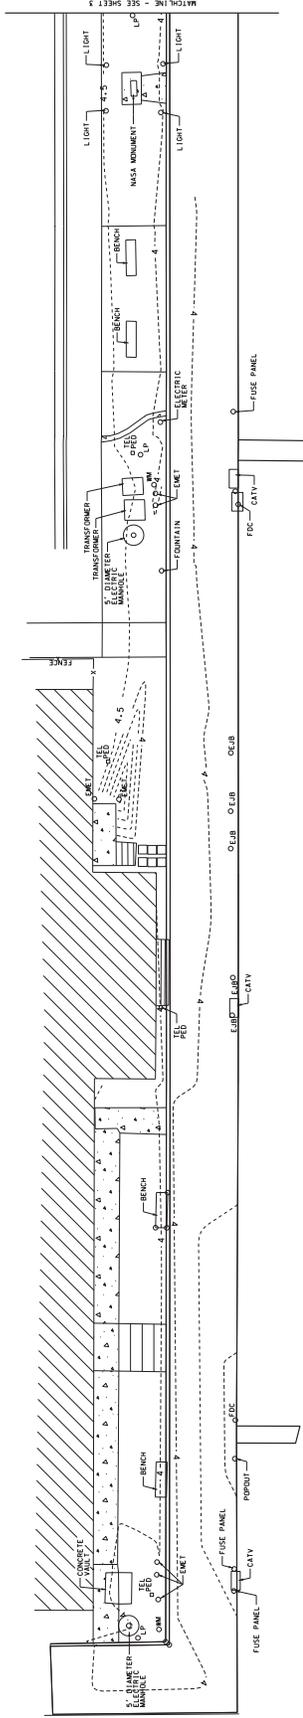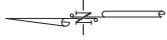EXISTING CONDITIONS & DEMOLITION PLAN

SCALE: 1"=10'



B
2

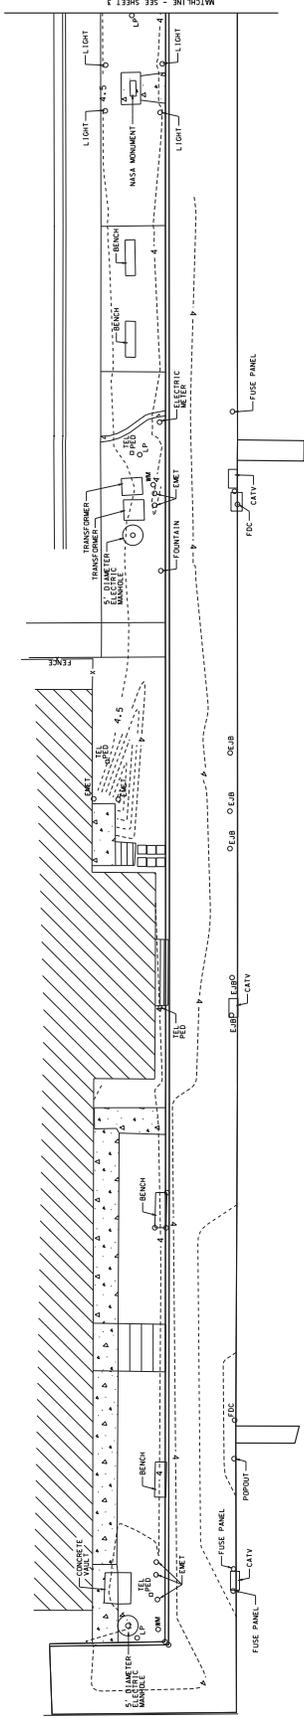PROPOSED CONDITIONS PLAN

SCALE: 1"=10'

REVISIONS

NO.	DATE	DESCRIPTION



SITE PLAN


BEAUFORT BULKHEAD & BOARDWALK REPAIR

BEAUFORT GARTNET COUNTY NORTH CAROLINA

OWNER: ADDRESS: PHONE:


DESIGNED: LES DATE: 2/8/18
 DRAWN: LNU SCALE: 1"=10'
 APPROVED: LES SHEET 2 OF 4



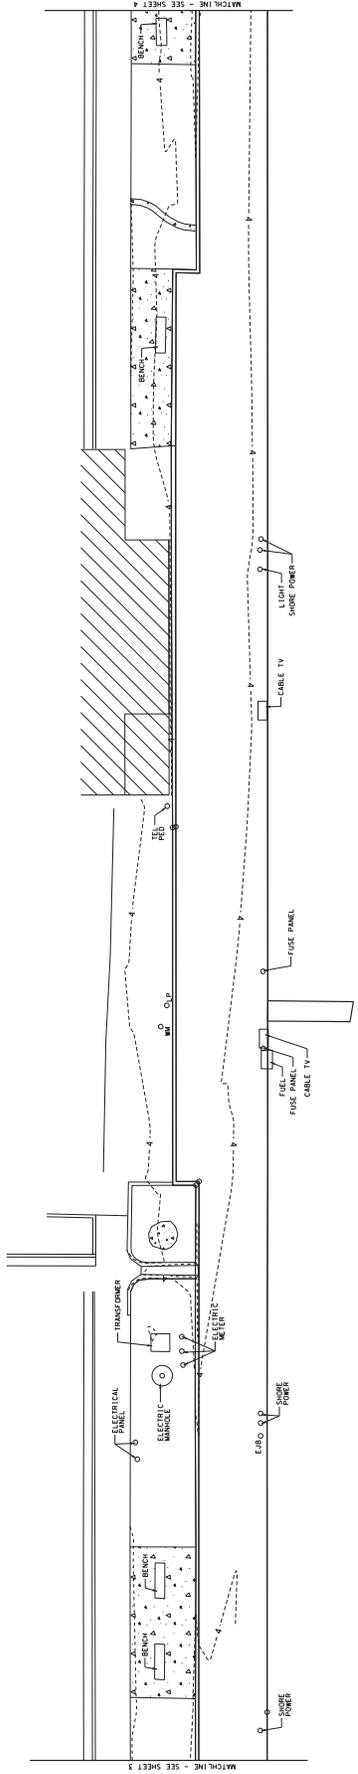

EXISTING CONDITIONS & DEMOLITION PLAN
SCALE: 1"=10'

A
3

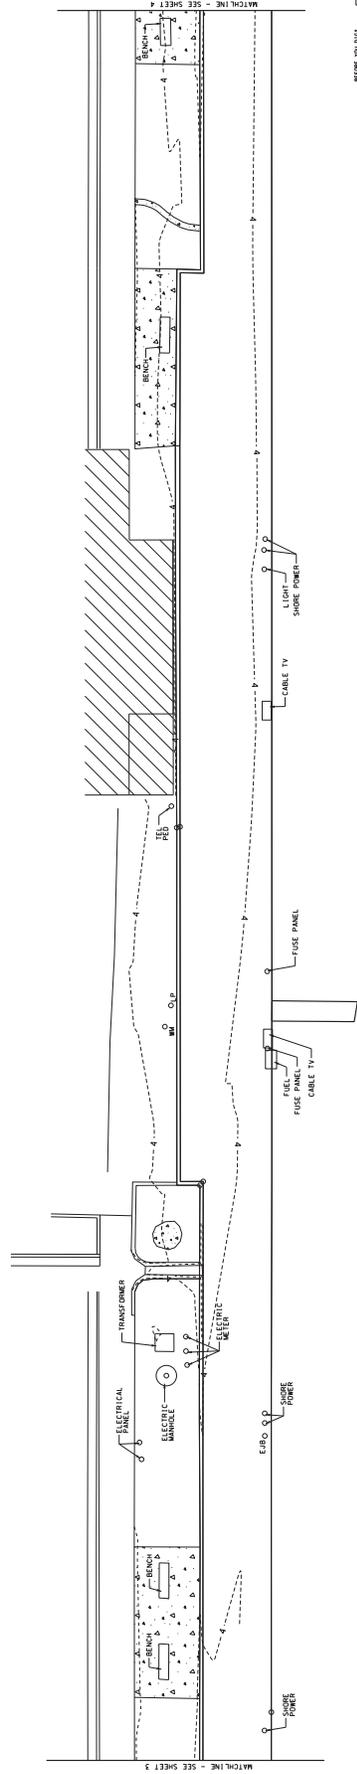

PROPOSED CONDITIONS PLAN
SCALE: 1"=10'

B
3

REVISIONS

NO.	DATE	DESCRIPTION

SITE PLAN


BEAUFORT BULKHEAD & BOARDWALK REPAIR

OWNER: BEAUFORT BOARDWALK REPAIR AUTHORITY
 ADDRESS: BEAUFORT, NORTH CAROLINA
 PHONE: (919) 739-4444


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 DATE: 2/8/18
 DRAWN: LES
 SCALE: 1"=10'

APPROVED: LES
 SHEET 3 OF 4



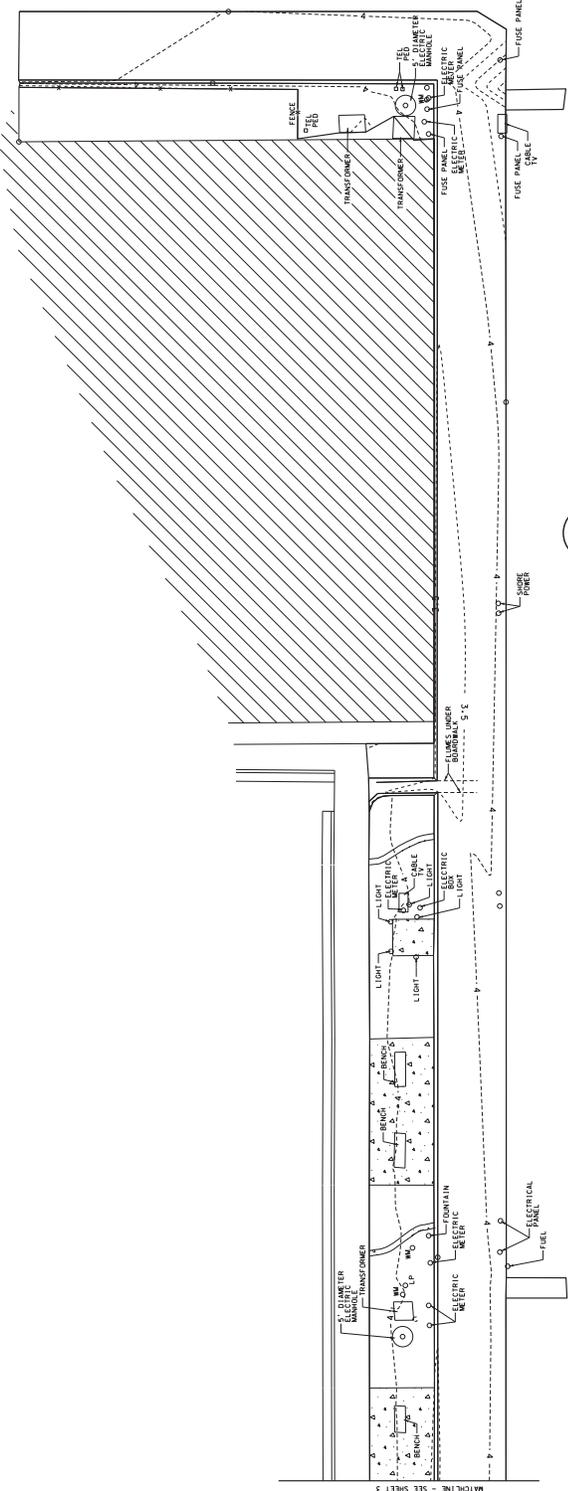

EXISTING CONDITIONS & DEMOLITION PLAN
SCALE: 1"=10'

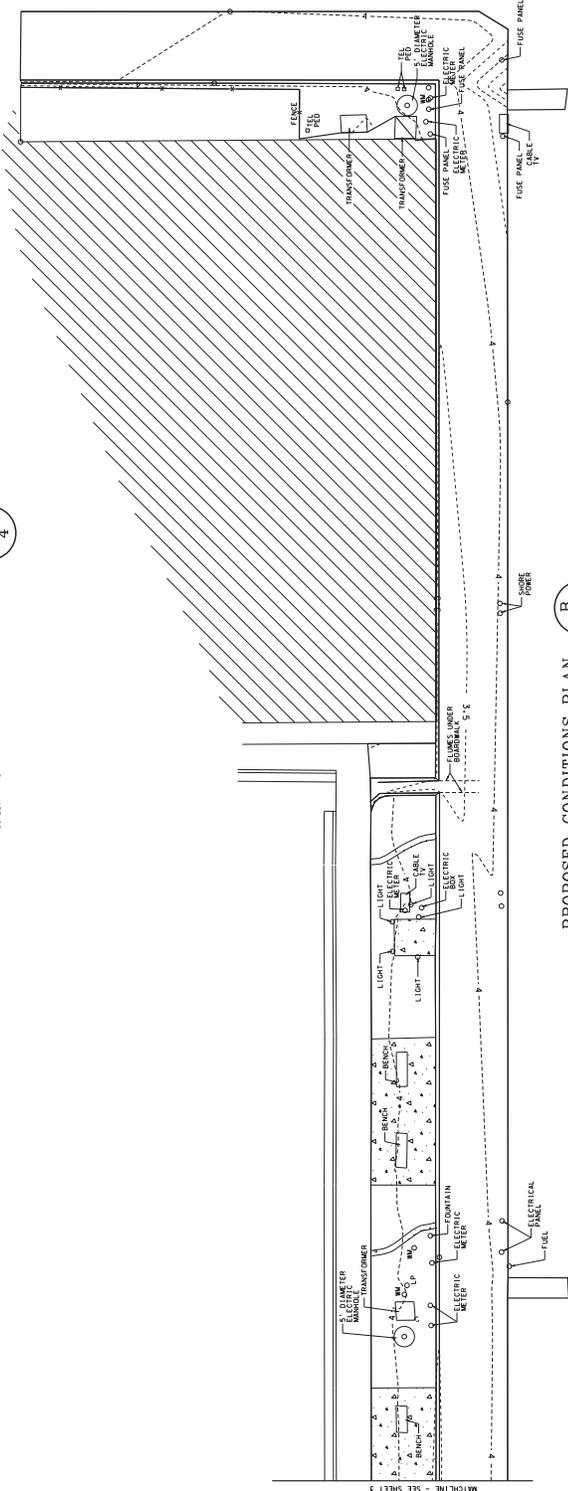

PROPOSED CONDITIONS PLAN
SCALE: 1"=10'



REVISIONS

NO.	DATE	DESCRIPTION



BEAUFORT BULKHEAD & BOARDWALK REPAIR
BEAUFORT, CURRUMET COUNTY, NORTH CAROLINA

OWNER: ADDRESS: PHONE: DESIGNED: LES DATE: 2/8/18
DRAWN: SCALE: 1"=10'
APPROVED: LES SHEET 4 OF 4

STROUD ENGINEERING, P.A.
2000 W. STATE ST. SUITE 5
LITTLE ROCK, AR 72117
PH: 501-221-1111

PROJECT NO.: 201803-3500
DRAWING NO.:

Project Beaufort Bulkhead and Boardwalk Repair
 Date 3/6/2018

LM Project # V17.065

Demolition of Existing Boardwalk and Concrete Seawall Pile Cap

Remove Hand Rails	9,000
940 linear feet	
Remove Deck Boards and wood framing	48,000
40,000 board feet	
Remove Concrete spread footing	15,000
940 linear feet	
Remove Pile Cap from Seawall	78,300
Saw cut 5 deep inches each side	
Temporary construction netting to keep concrete from water	
Break up with jack hammer	
Dispose of Debris	65,000
720 tons Load and Haul to dump (includes dump fee of \$38/ton)	
Erosion and Sediment Control	8,000
Temporary Fencing to Close off site (Assume 6 month Duration)	24,000

Construction of New Boardwalk and Concrete Seawall Pile Cap

Helical Piles	67,200
96 Piles 20 feet long	
Concrete for Pile Cap and Grade Beam	208,200
305 cubic yards concrete	
22 tons of rebar	
Formwork	
Clean seawall for form installation	
Concrete Admixture for waterproofing pile cap	10,800
Velosit CA 115	
Excavate behind seawall and backfill with lean concrete	67,500
425 cubic yards of excavation	
425 cubic yards of lean concrete	
Remove 4' of Tie rods and replace	12,000
46 Tie rods	
Regrade soils below boardwalk	17,200
Install crushed stone layer under boardwalk	39,900
15,000 sf of Filter Fabric	
220 cubic yards of crushed stone	
Rebuild Boardwalk	162,200
11860 SF of boardwalk	
Pressure Treated #2 Southern Pine	
Galvanized Bolts and Nails	
Stainless steel deck screws	
Install Gaurdrails	38,200
940' railing (Wire and pressure treated wood)	
Inspections and Testing	14,800
Mobilization	12,000
	Total
	885,300
Unforeseen conditions contingency (20%)	177,060
Overhead and profit	159,354

GRAND TOTAL 1,221,714



STROUD ENGINEERING, P.A.

CONSULTING ENGINEERS
HESTRON PLAZA TWO
151-A HWY. 24
MOREHEAD CITY, NC 28557
(252) 247-7479

April 10, 2017

Mr. Mark Eakes
Town of Beaufort
Public Works Director
701 Front Street
Beaufort, North Carolina 28516

Re: Preliminary Structural Assessment- Town of Beaufort Front Street Waterfront Plaza

Dear Mr. Eakes,


At your request and in your presence, I made a couple of site visits to the boardwalk area to evaluate the issues identified with the settlement in and around the Dock House. On the second visit, we had Mr. Carl Bonner, P.E., Terracon, a geotechnical firm with a branch located in Greenville, with us as well. Without knowing the original proposed construction details, it was difficult to develop a theory on what was happening. Logic was not making sense with the observations we were seeing. With assistance of several people we were able to ascertain that the original design engineering firm was Rivers and Associates, also from Greenville. Mr. Bonner was able to locate those drawings from Rivers and Associates and we have provided a copy of those drawings to you and have saved a set here as well.

The old drawings have a detail that answers the questions to what is happening. The landward support for the deck joists is supported by a concrete footing without vertical support, (we had been led to believe that this was actually a retaining wall) as time passes on, siltation of the underlying material weeps through the bulkhead and allows settlement of this footing. A permanent repair solution would be to replace this footing with a pile supported footing so that in the future should future loss of material occur the footing would not settle and be structurally independent. This solution would not be cheap. Band aid solutions would be to place soil between the outer wall and this footing and provide some type of weep protection thru the seawall, replace the footing at the proper elevation and then blend the sidewalks back into the boardwalk.

Additionally, during our investigation efforts, significant concrete spalling and corrosive rebar was evident on the seawall and those structural repairs need to be initiated soon as well.

Please review and advise how you would like us to move forward. If you have any questions, please let me know.

Sincerely,

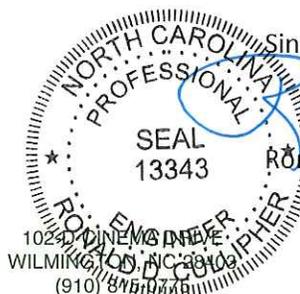

Ronald D. Cullipher, P.E.

107 COMMERCE ST.
SUITE B
GREENVILLE, NC 27858
(252) 756-9352

HESTRON PLAZA TWO
151-A HWY. 24
MOREHEAD CITY, NC 28557
(252) 247-7479